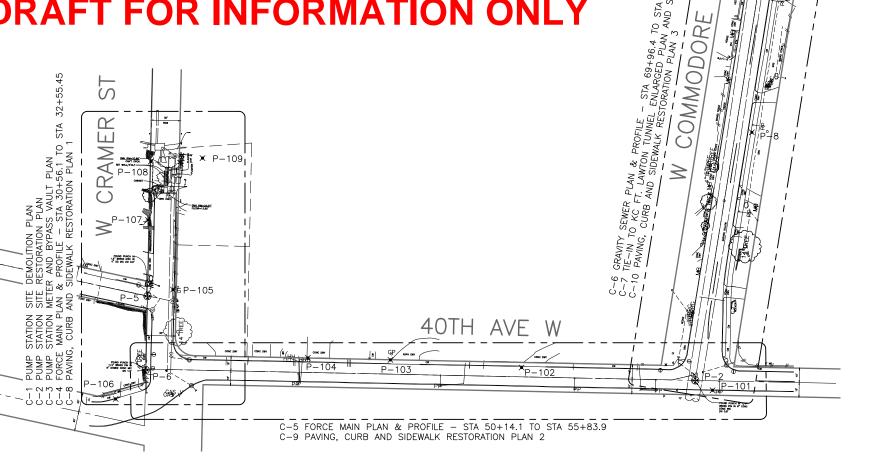


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FOUND FUNCH IN 1/ SPASS FLUG IN 6" DOMED COME MIC

FOUND PUNCH IN 1/3 BEXES PLUG IN 6" DOMED CONC MC

CDM Smith 14432 SE Eastgate Way

REVIEWED BY SPU/WATER ENGINEERING REVIEWED BY SPU/DRAINAGE 20.. APPROVED BY SDOT STREET IMPROVEMENT PERMITTING

40TH AVE W

APPROVED FOR ADVERTISING LIZ ALZEER DEPARTMENT OF FINANCE & ADMINISTRATIVE SERVICES SEATTLE, WASHINGTON 20

INITIALS AND DATE INITIALS AND DATE ESIGNED NEK 03/07/2018 HECKED JNC 03/07/2018 RECEIVED #### REVISED AS BUILT ####



City of Seattle Seattle Public Utilities ORDINANCE NO. Ordinance PW NO. #### FUND: Fund

PS22 RETROFIT AND FORCE MAIN REPLACEMENT PROJECT C-0

OVERALL SITE PLAN

AND SURVEY CONTROL PLAN

PLAN NO. **776-474** SHEET 15 OF


- 1. CLEAR AND GRUB SOFTSCAPE AREAS WITHIN THE RIGHT-OF-WAY UP TO BEHIND THE CURB LINE.
- 2. CONTRACTOR TO VERIFY WITH OWNER PRIOR TO DEMOLITION IF ANY EQUIPMENT OR MATERIALS ARE TO BE SALVAGED.
- CONTRACTOR SHALL CLEARLY MARK PROPERTY BOUNDARIES PRIOR TO ANY DEMOLITION REMOVAL OF PLANTINGS AND LANDSCAPING OUTSIDE OF THE RIGHT-OF-WAY REQUIRES
- PRIVATE RESIDENCE APPROVAL. 5. SPU TO PROCURE TEMPORARY EASEMENT AGREEMENT FOR CONSTRUCTION WORK OUTSIDE
- 6. WORK NOT IN THE ROW TO BE COORDINATED WITH THE RESIDENT.

OF THE RIGHT-OF-WAY.


- REMOVE ABOVE-GRADE CSO LEVEL MONITORING CABINET AND CONCRETE EQUIPMENT PAD. CSO MONITORING SHALL REMAIN CONTINUOUS THROUGHOUT CONSTRUCTION. CONTRACTOR TO SCHEDULE CSO LEVEL MONITORING CABINET REMOVAL TO OCCUR AFTER THE NEW CSO LEVEL MONITORING IS INSTALLED AND FUNCTIONAL. COORDINATE WITH ADS TO REPLACE THEIR MONITORING EQUIPMENT WITH BATTERY POWERED MONITORING IN MH010-159 PRIOR TO THE REMOVAL OF THE EXISTING MONITORING CABINET.
- REMOVE ALL PIPING, VALVES AND APPURTENANCES LOCATED WITHIN THE BYPASS CONNECTION VAULT. REMOVE VAULT LID, MANHOLE COVER AND RISERS AND STRUCTURE TO A MINIMUM OF 5-FT BELOW FINISHED GRADE. REMOVE 8-INCH DIAMETER YARD PIPING CONNECTING THE PUMP STATION DISCHARGE TO THE BYPASS CONNECTION VAULT. PERMANENTLY PLUG THE 8-INCH DIAMETER CAST IRON FORCE MAIN DOWNSTREAM OF THE BYPASS CONNECTION VAULT WITH A MINIMUM 12-INCH LONG PLUG OF 3,000 PSI CONCRETE. FILL VAULT WITH STRUCTURAL BACKFILL (TYPE 17 MINERAL AGGREGATE) AND REPAIR CURB, SIDEWALK, AND STREET SURFACING PÈR THE 2017 SDOT ROWORR REQUIREMENTS. CONTRACTOR SHALL USE THE EXISTING FORCE MAIN AND BYPASS CONNECTION VAULT THROUGHOUT CONSTRUCTION UNTIL THE NEW FORCE MAIN AND KING COUNTY INTERCEPTOR CONNECTION ARE INSTALLED AND IN OPERATION. CONTRACTOR TO SCHEDULE THE BYPASS CONNECTION VAULT DEMOLITION ACCORDINGLY.
- 3 REMOVE BACKFLOW PREVENTION DEVICE (BPD) AND ENCLOSURE. TEMPORARILY CAP THE 1-INCH DIAMETER WATER CONNECTION PIPE TO BE RECONNECTED TO NEW BPD DEVICE AND ENCLOSURE.
- (4) REMOVE FUEL STORAGE TANK, FUELING PIPING, GENERATOR CONCRETE EQUIPMENT PAD, WOODEN FENCING AND WOODEN TRELLIS. EXISTING STANDBY GENERATOR TO BE USED DURING PUMP STATION SERVICE UPGRADE. CONTRACTOR TO SCHEDULE THE GENERATOR REMOVAL AND ASSOCIATED DEMOLITION ACCORDINGLY. CONTRACTOR TO REMOVE AND SALVAGE STANDBY GENERATOR.
- (5) REMOVE AND REPLACE CATCH BASIN. PROTECT STORM PIPING AND IF DAMAGED REPLACE
- 6 REMOVE SIDEWALK, CURB, GUTTER, FENCING, TREES AND SHRUBS.
- (7) REMOVE PLANTERS. SEE GENERAL NOTE NO. 4.
- (8) PRESERVE AND PROTECT PUMP STATION STRUCTURE, STAIRS, AND CHAIN-LINK FENCING.
- (9) PRESERVE AND PROTECT CSO CONTROL STRUCTURE.
- (10) PRESERVE AND PROTECT SHORELINE RETAINING WALL.
- (1) REMOVE SHRUB OR TREE. SEE GENERAL NOTE NO. 4.
- (12) REMOVE AND RELOCATE SIGN TO LOCATION SHOWN ON C-2.
- (3) REMOVE ROCKERY WALL WITHIN THE RIGHT-OF-WAY. THE CONTRACTOR WILL NOTIFY PRIVATE RESIDENCE TWO WEEKS IN ADVANCE OF ROCK WALL REMOVAL.
- (14) REMOVE EXISTING GUARD RAIL.
- (15) REMOVE WOODEN FENCE UP TO THE EDGE OF THE RIGHT-OF-WAY

PUMP STATION SITE DEMOLITION PLAN

PS22 RETROFIT AND FORCE MAIN

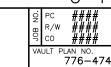

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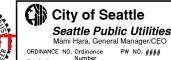
REVIEWED BY SPU/WATER ENGINEERING REVIEWED BY SPU/DRAINAGE 20. APPROVED BY SDOT STREET IMPROVEMENT PERMITTING

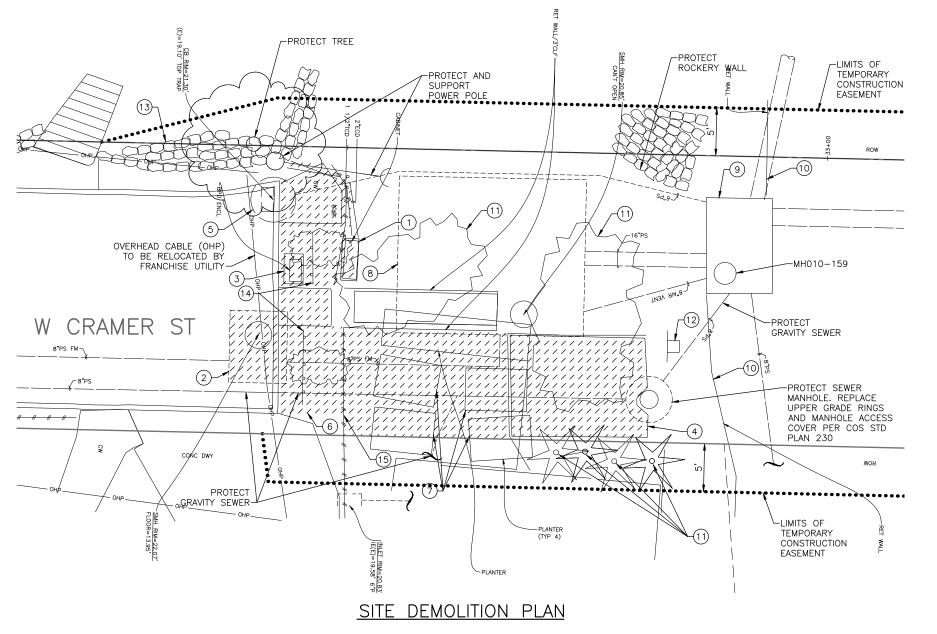APPROVED FOR ADVERTISING 117 AL 7FFR DEPARTMENT OF FINANCE & ADMINISTRATIVE SERVICES SEATTLE, WASHINGTON 20

CITY PURCHASING & CONTRACTING SERVICES DIRECTOR

INITIALS AND DATE INITIALS AND DATE ESIGNED NEK 03/07/2018 ES. #### HECKED JNC 03/07/2018 DOT #### DRAWN JDR 03/07/2018 CHECKED CEB 03/07/2018 RECEIVED #### REVISED AS BUILT #### LL WORK SHALL BE DONE IN ACCORDANCE WITH THE CITY OF SEATTLE STANDARD PLANS A






REPLACEMENT PROJECT

776-474 SHEET 16 OF

Smith

14432 SE Eastgate Way

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GENERAL NOTES:

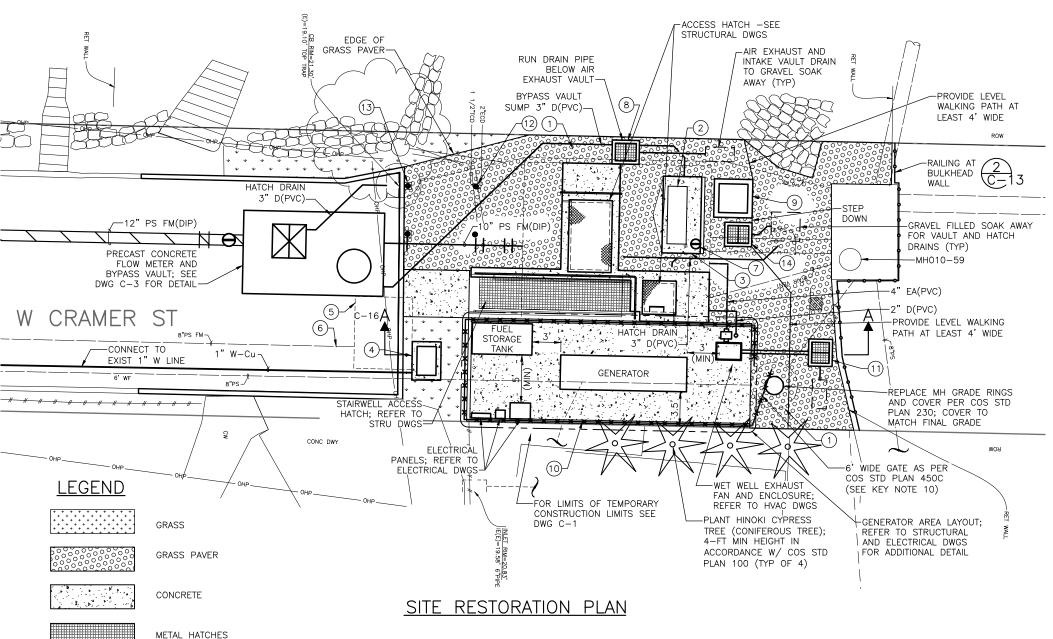UNLESS OTHERWISE NOTED:

- 1. WORK NOT IN THE ROW TO BE COORDINATED WITH THE RESIDENT.
- 2. OVERHEAD CABLE (OHP) WITHIN ROW AT PUMP STATION SITE TO BE RELOCATED BY

- GRASS PAVER FINISHED GRADE TO MATCH SITE CONTOURS, TOP OF CURBS AND PUMP STATION CONCRETE STRUCTURES AS APPROPRIATE, AND AS SHOWN. GRASS PAVER TO SUPPORT MAINTENANCE VEHICLE PARKING AND PROVIDE EROSION PROTECTION. SEE
- PARK BENCH SHALL BE 6-FT SPR STANDARD GENERIC PIPE FRAME BENCH; GAME TIME, INC. MODEL #338 - PIPE FRAME ONLY, SUPPLIED BY SITELINES - PARK & PLAYGROUND PRODUCTS. BOARDS SHALL BE DOUGLAS FIR (STRUCTURAL OR BETTER GRADE), 2x4'S THAT HAVE ALL OUTSIDE EDGES ROUTERED SMOOTH AND BOLTED TO THE FRAME USING GALVANIZED HARDWARE.
- PARK BENCH SHALL BE INSTALLED ON 4-INCH THICK CAST-IN-PLACE CONCRETE PAD THAT EXTENDS 1-FT BEYOND THE BENCH IN ALL DIRECTIONS.
- (4) BACKFLOW PREVENTION DEVICE (BPD) WITH CAST-IN-PLACE CONCRETE EQUIPMENT PAD AND ENCLOSURE. SEE DETAIL 4/C-14.
- ABANDONED-IN-PLACE BYPASS VAULT. VAULT SHALL NOT BE DECOMMISSIONED UNTIL THE NEW FORCE MAIN AND KC FORT LAWTON TUNNEL CONNECTION ARE COMPLETED AND
- PLUG AND ABANDON—IN—PLACE 8—INCH DIAMETER FORCE MAIN. FORCE MAIN SHALL NOT BE DECOMMISSIONED UNTIL THE NEW FORCE MAIN AND KC FORT LAWTON TUNNEL CONNECTION ARE COMPLETED AND OPERATIONAL.
- INSTALL VALVE BOX COVER PER COS STD DETAIL 315 WITH OPERATING NUT FOR WET WELL ISOLATION SLIDE GATE. REFER TO MECHANICAL DRAWINGS FOR ADDITIONAL REQUIREMENTS
- (8) DRY WELL EXHAUST VAULT; REFER TO HVAC DRAWINGS FOR ADDITIONAL DETAILS. PROVIDE VAULT DRAIN TO GRAVEL FILLED SOAK AWAY.
- (9) WET WELL INTAKE FAN VAULT; REFER TO HVAC DRAWINGS FOR ADDITIONAL DETAILS.
- (10) TYPE 1 CHAIN LINK FENCE PER COS STD PLAN 450.
- (1) WET WELL EXHAUST VAULT; REFER TO HVAC DRAWINGS FOR ADDITIONAL DETAILS. PROVIDE VAULT DRAIN TO GRAVEL FILLED SOAK AWAY.
- (2) TWO FIXED BOLLARDS PER COS STD PLAN 463 (TYPE A) AT END OF EACH PAVER RIBBONS AND MIN 4'-0" OFFSET FROM THE EDGE OF THE PUMP STATION STRUCTURE.
- (3) TWO REMOVABLE BOLLARDS PER COS STD PLAN 463 (TYPE A) AT START OF EACH PAVER RIBBON NEXT TO THE CURB.
- (4) WET WELL SUPPLY AIR INLET VAULT. REFER TO HVAC DRAWINGS FOR ADDITIONAL DETAILS. PROVIDE VAULT DRAIN TO GRAVEL FILLED SOAK AWAY.

PUMP STATION SITE RESTORATION PLAN

80% DESIGN- FOR INFO (NOT FOR CONSTRUCTION)

UTILITY BOX GRATING

CDM **Smith** 14432 SE Eastgate Way Bellevue, WA 98007 Tel: (425) 519-8300

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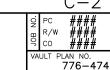
CITY PURCHASING & CONTRACTING SERVICES DIRECTOR

INITIALS AND DATE INITIALS AND DATE ESIGNED NEK 03/07/2018 CONST. #### PROJ. MGR. ### ES. #### HECKED JNC 03/07/2018 DOT #### DRAWN JDR 03/07/2018 CHECKED CEB 03/07/2018 RECEIVED #### REVISED AS BUILT #### LL WORK SHALL BE DONE IN ACCORDANCE WITH THE CITY OF SEATTLE STANDARD PLANS A







PS22 RETROFIT AND FORCE MAIN REPLACEMENT PROJECT



SHEET 17 OF

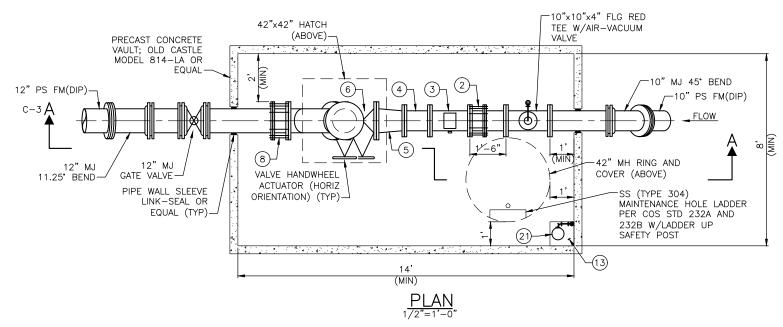

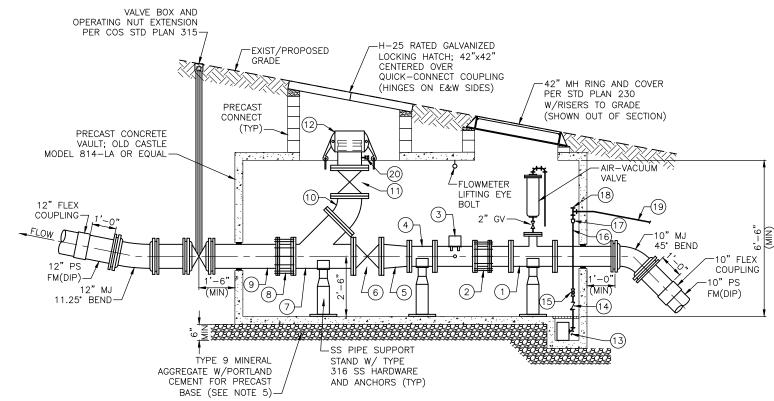

- NOTES:

 1. REFER TO ELECTRICAL DRAWINGS FOR FLOW METER POWER AND SIGNAL CONDUIT AND WIRING
- 2. BURIED MJ FITTINGS ARE TO BE RESTRAINED.
- 3. PROVIDE FLOW METER SPOOL PIECE (LIST ITEM NO. 4).
- WITH 3" CORP STOP FOR 1" COMBINATION VALVE.
- 5. MINIMUM REQUIRED SOIL BEARING = 3,000 LBS/SQ FT.

BYPASS VAULT KEY NOTES

ITEM NUMBER	DESCRIPTION	REMARKS
1	10"X10"X4" REDUCING TEE (DI, FLXFL)	
2	10" FLANGED COUPLING ADAPTER	
3	10" FLOW METER	
4	10" SPOOL PIECE FOR FLOW METER REPLACEMENT	STORE IN VAULT
5	12"X10" FLANGED CONCENTRIC REDUCER	
6	12" GATE VALVE	
7	12"X12"X12" FLANGED WYE	
8	12" FLANGED COUPLING ADAPTER	
9	12" SPOOL PIECE	
10	12" FLANGED 45° BEND	
11	PROVIDE GATE VALVE W/CHAIN FOR HANDWHEEL ACTUATOR	
12	12" QUICK-CONNECT COUPLING	
13	12"X12"X12" (MIN SUMP) W/FRP GRATING (NOT SHOWN)	
14	1½" CHECK VALVE	
15	1½" BALL VALVE	
16	1½" SCH 80 PVC PIPE	
17	3"X1½" PVC REDUCER	
18	3" TEE W/CAP ON ONE BRANCH	
19	3" SCH 80 PVC PIPE TO WET WELL	
20	CORP STOP	
21	1½ HP SUMP PUMP	

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SCALE IN FEET PUMP STATION FLOW METER AND BYPASS VAULT PLAN

SCALE: AS NOTED

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CDM Smith 14432 SE Eastgate Way

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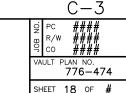
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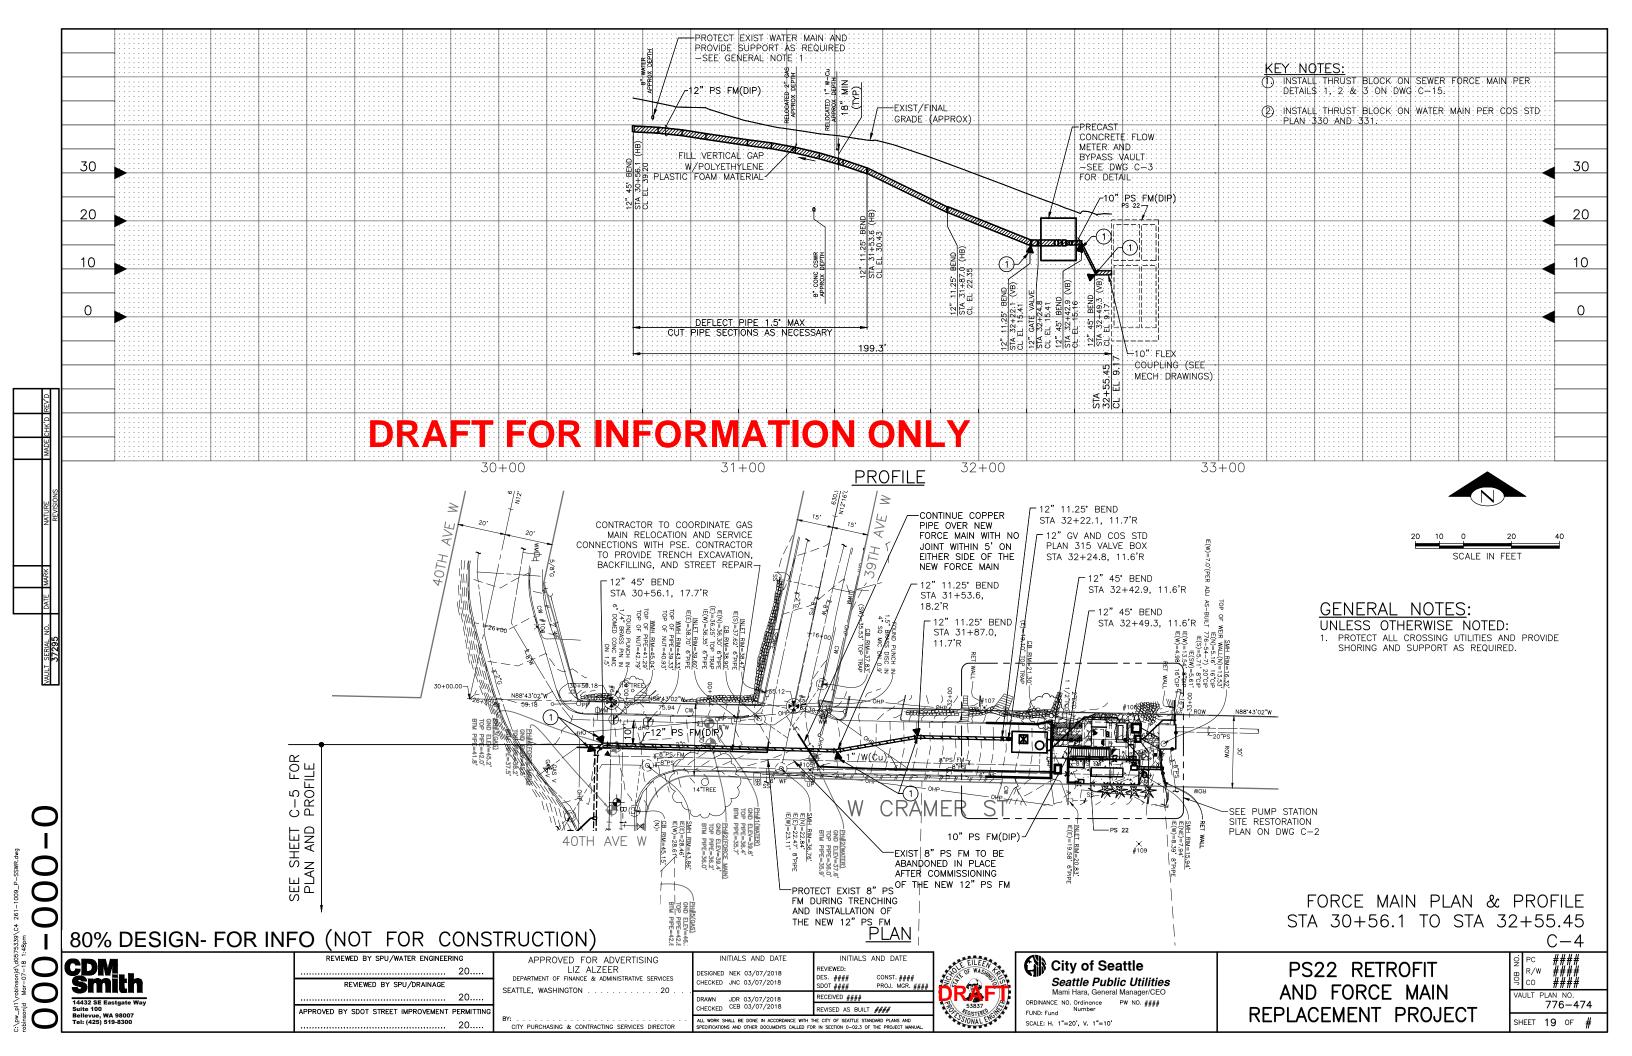
INITIALS AND DATE INITIALS AND DATE ESIGNED NEK 03/07/2018 ES. #### HECKED JNC 03/07/2018 DOT #### DRAWN JDR 03/07/2018 CHECKED CEB 03/07/2018 RECEIVED #### REVISED AS BUILT #### ull work shall be done in accordance with the city of seattle standard plans a specifications and other documents called for in section 0-02.3 of the project








PS22 RETROFIT AND FORCE MAIN REPLACEMENT PROJECT





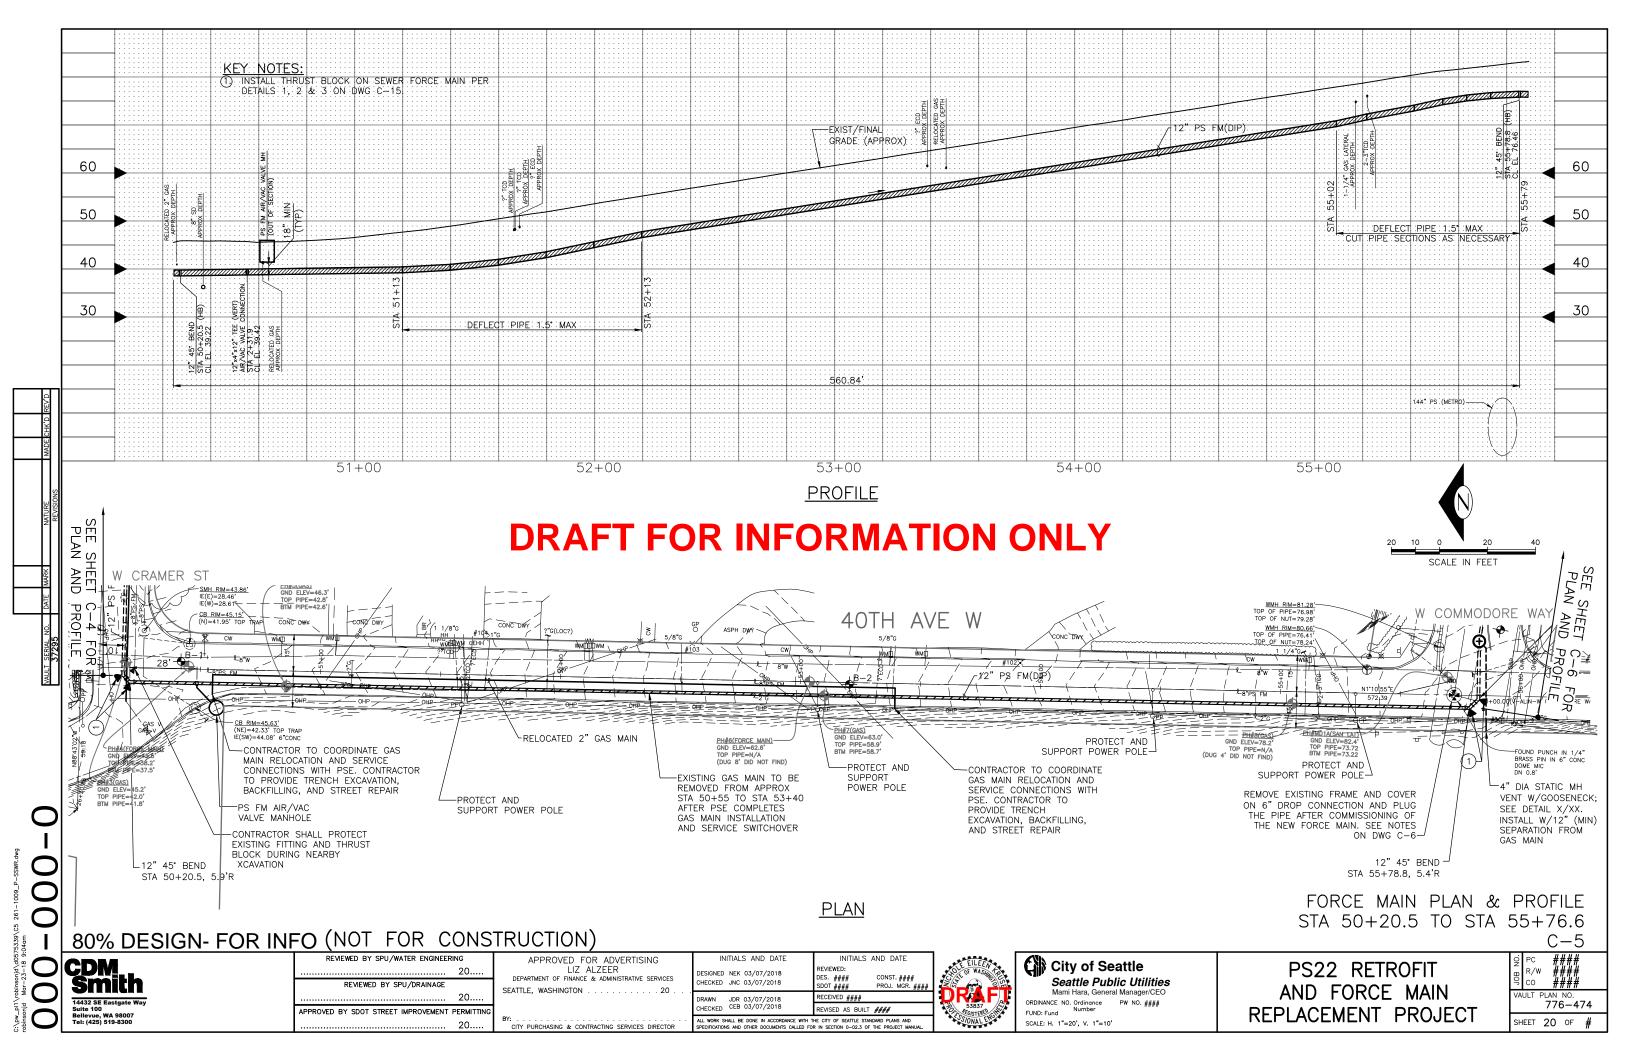


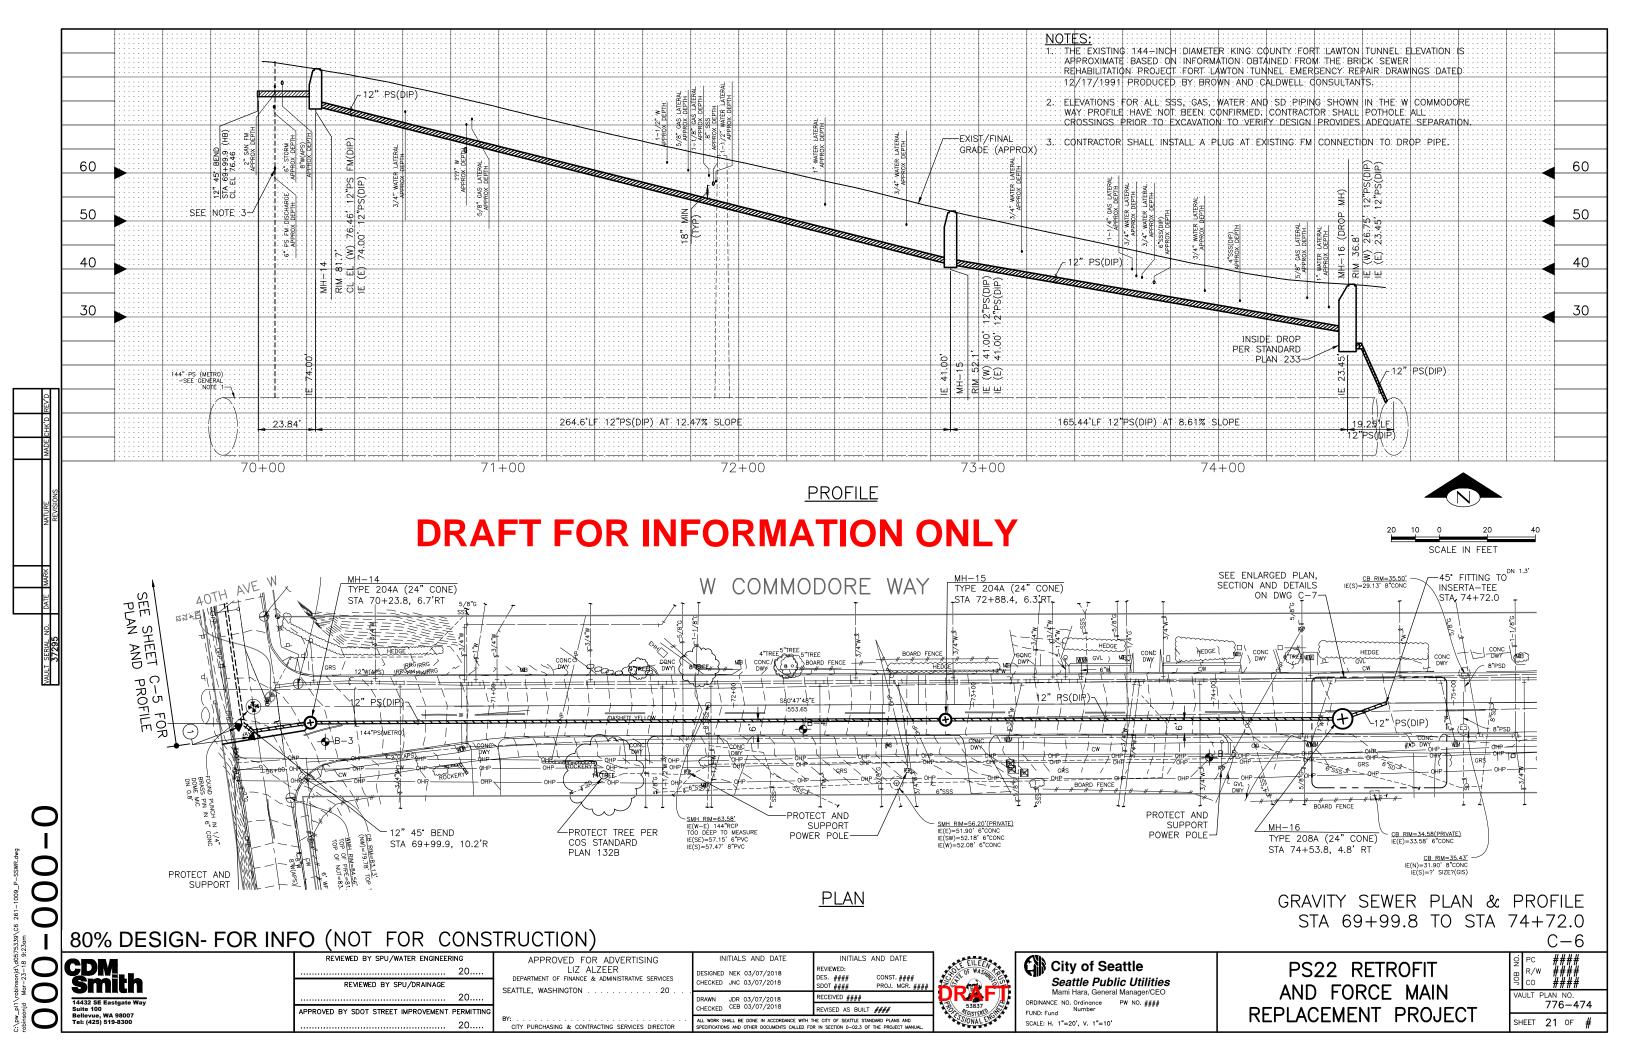

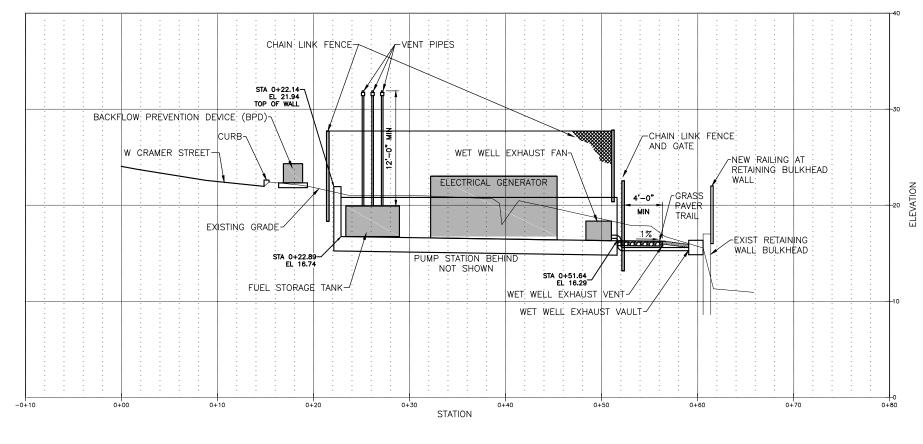

 $\frac{\text{SECTION A-A, C-2}}{1=1'-0''}$

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PUMP STATION SITE SECTION STA 0+00 TO STA 75+00 C - 16

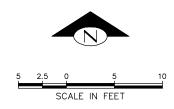PS22 RETROFIT AND FORCE MAIN REPLACEMENT PROJECT

PLAN NO. 776-474 SHEET 30 OF #

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REVIEWED BY SPU/DRAINAGE 20.. APPROVED BY SDOT STREET IMPROVEMENT PERMITTING

APPROVED FOR ADVERTISING LIZ ALZEER DEPARTMENT OF FINANCE & ADMINISTRATIVE SERVICES SEATTLE, WASHINGTON 20 .

INITIALS AND DATE INITIALS AND DATE ESIGNED NEK 03/07/2018 CHECKED JNC 03/07/2018 DRAWN OMN 03/07/2018 CHECKED CEB 03/07/2018 RECEIVED #### REVISED AS BUILT ####



